



- MATERIAL KEY**
- (A) METAL CHANNEL FACIA
 - (B) SIMULATED WOOD SIDING (VERTICAL)
 - (C) CEMENTITIOUS BOARD SIDING (HORIZONTAL)
 - (D) COMPOSITE METAL SIDING
 - (E) MASONRY VENEER
 - (F) TEXTURED PLASTER FINISH BASE
 - (G) CEMENTITIOUS PANEL SYSTEM
 - (H) METAL FACING
 - (J) TIMBER SCREEN AT GLAZING
 - (K) RECLAIMED TIMBER RETAINING

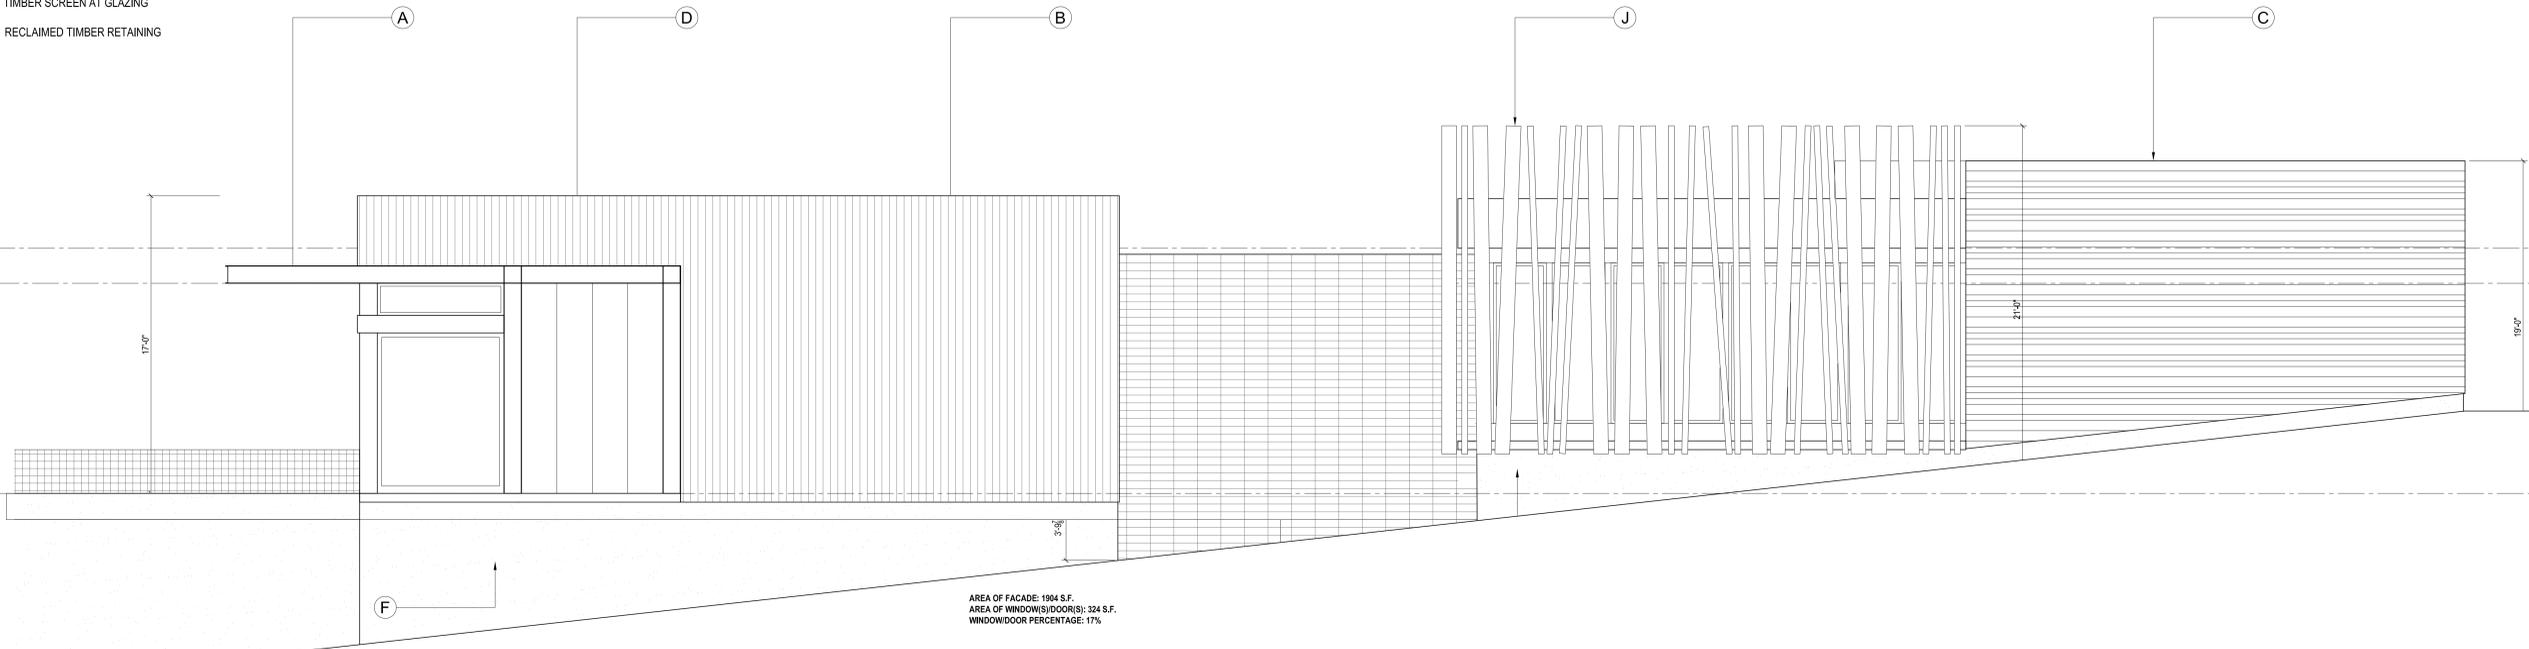

2 HEATH/FITNESS WING SOUTH ELEVATION
A4.15 SCALE: 1/8"=1'-0"

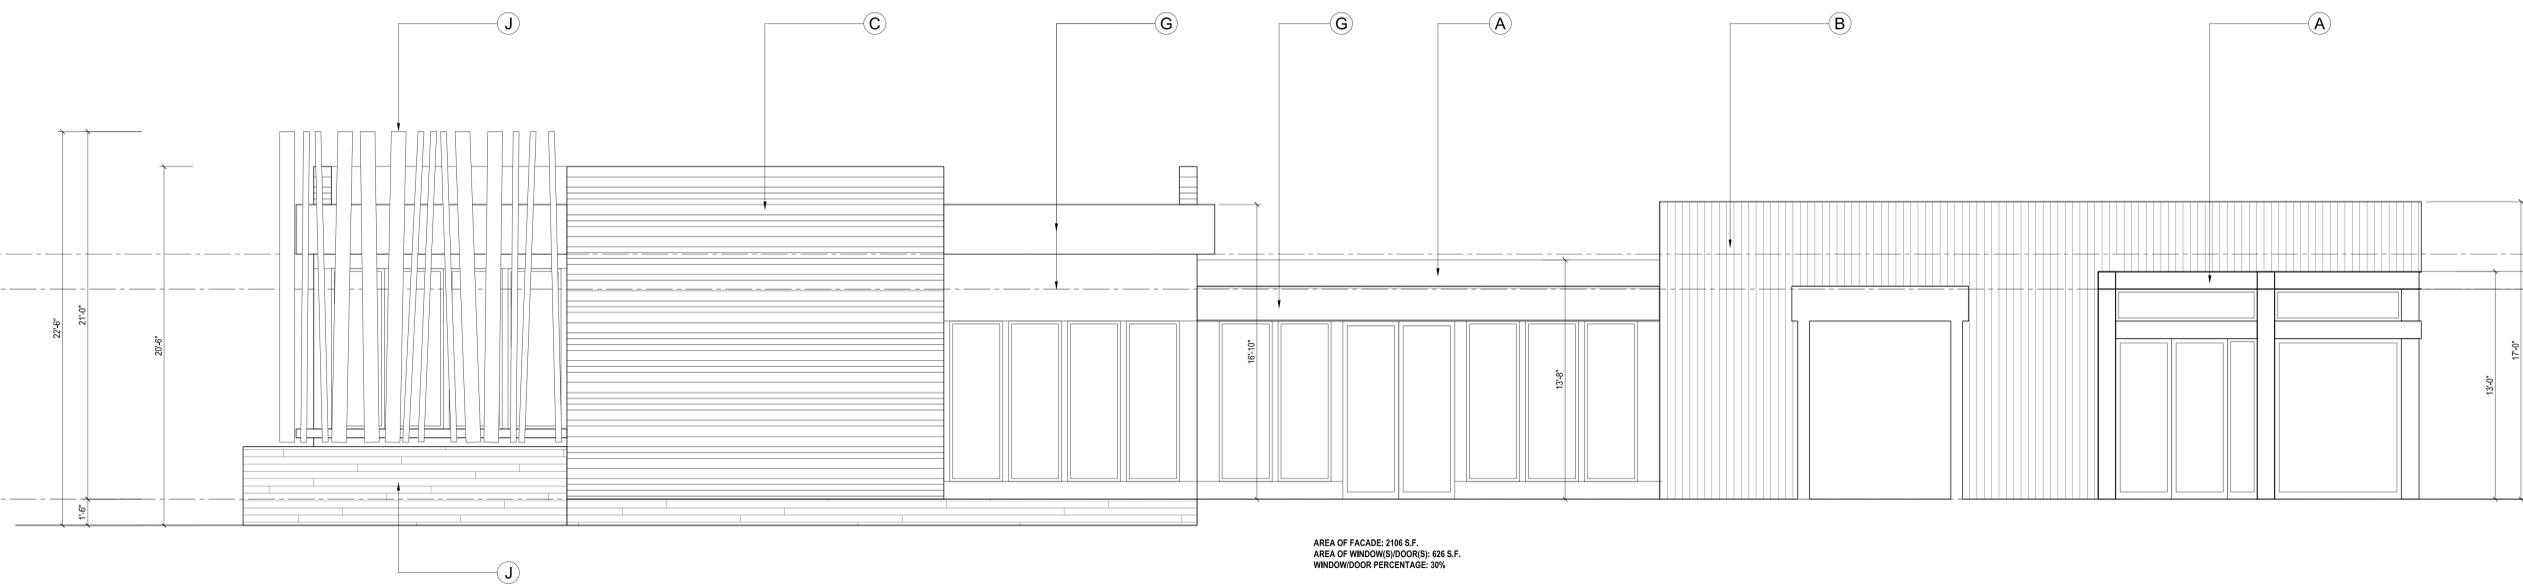

1 HEATH/FITNESS WING NORTH ELEVATION
A4.15 SCALE: 1/8"=1'-0"

ATTACHMENT "Z" - 41

General Notes:

No.	Date	Description
1	10.06.14	

Submissions & Revisions

Owner: **CORE CAMPUS**

Architect: **ANTUNOVICH ASSOCIATES ARCHITECTS PLANNERS**
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General Contractor:

Structural Engineer:

Landscape Architect:

M.E.P. & F.P. Engineers:

Civil Engineer:

Project Location:
HUB AT CORVALLIS
 CORVALLIS, OREGON

Drawing Title:
AMENITY BUILDING ELEVATIONS

Seal: _____ Date: _____
 Project No: _____
 Drawing No: **A-4.15**

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